

PROJECT NAME:

ACUA GEOTHERMAL WELLFIELD REPLACEMENT

ACUA PROJECT NO.: **2022-SW-04**

REVISIONS

THOMAS R. GANARD

CHIEF ENGINEER
PROFESSIONAL ENGINEER
NJ LICENSE NO. GE03526100

ATLANTIC COUNTY UTILITIES AUTHORITY

6700 DELILAH ROAD EGG HARBOR TOWNSHIP, NJ 08234

DRAWN:

CHECK:

T.G.


SHEET TITLE:

GEOTHERMAL
BOREFIELD SITE PLAN

DWG NO

1 OF 3

SCALE: DATE: **04/26/22**

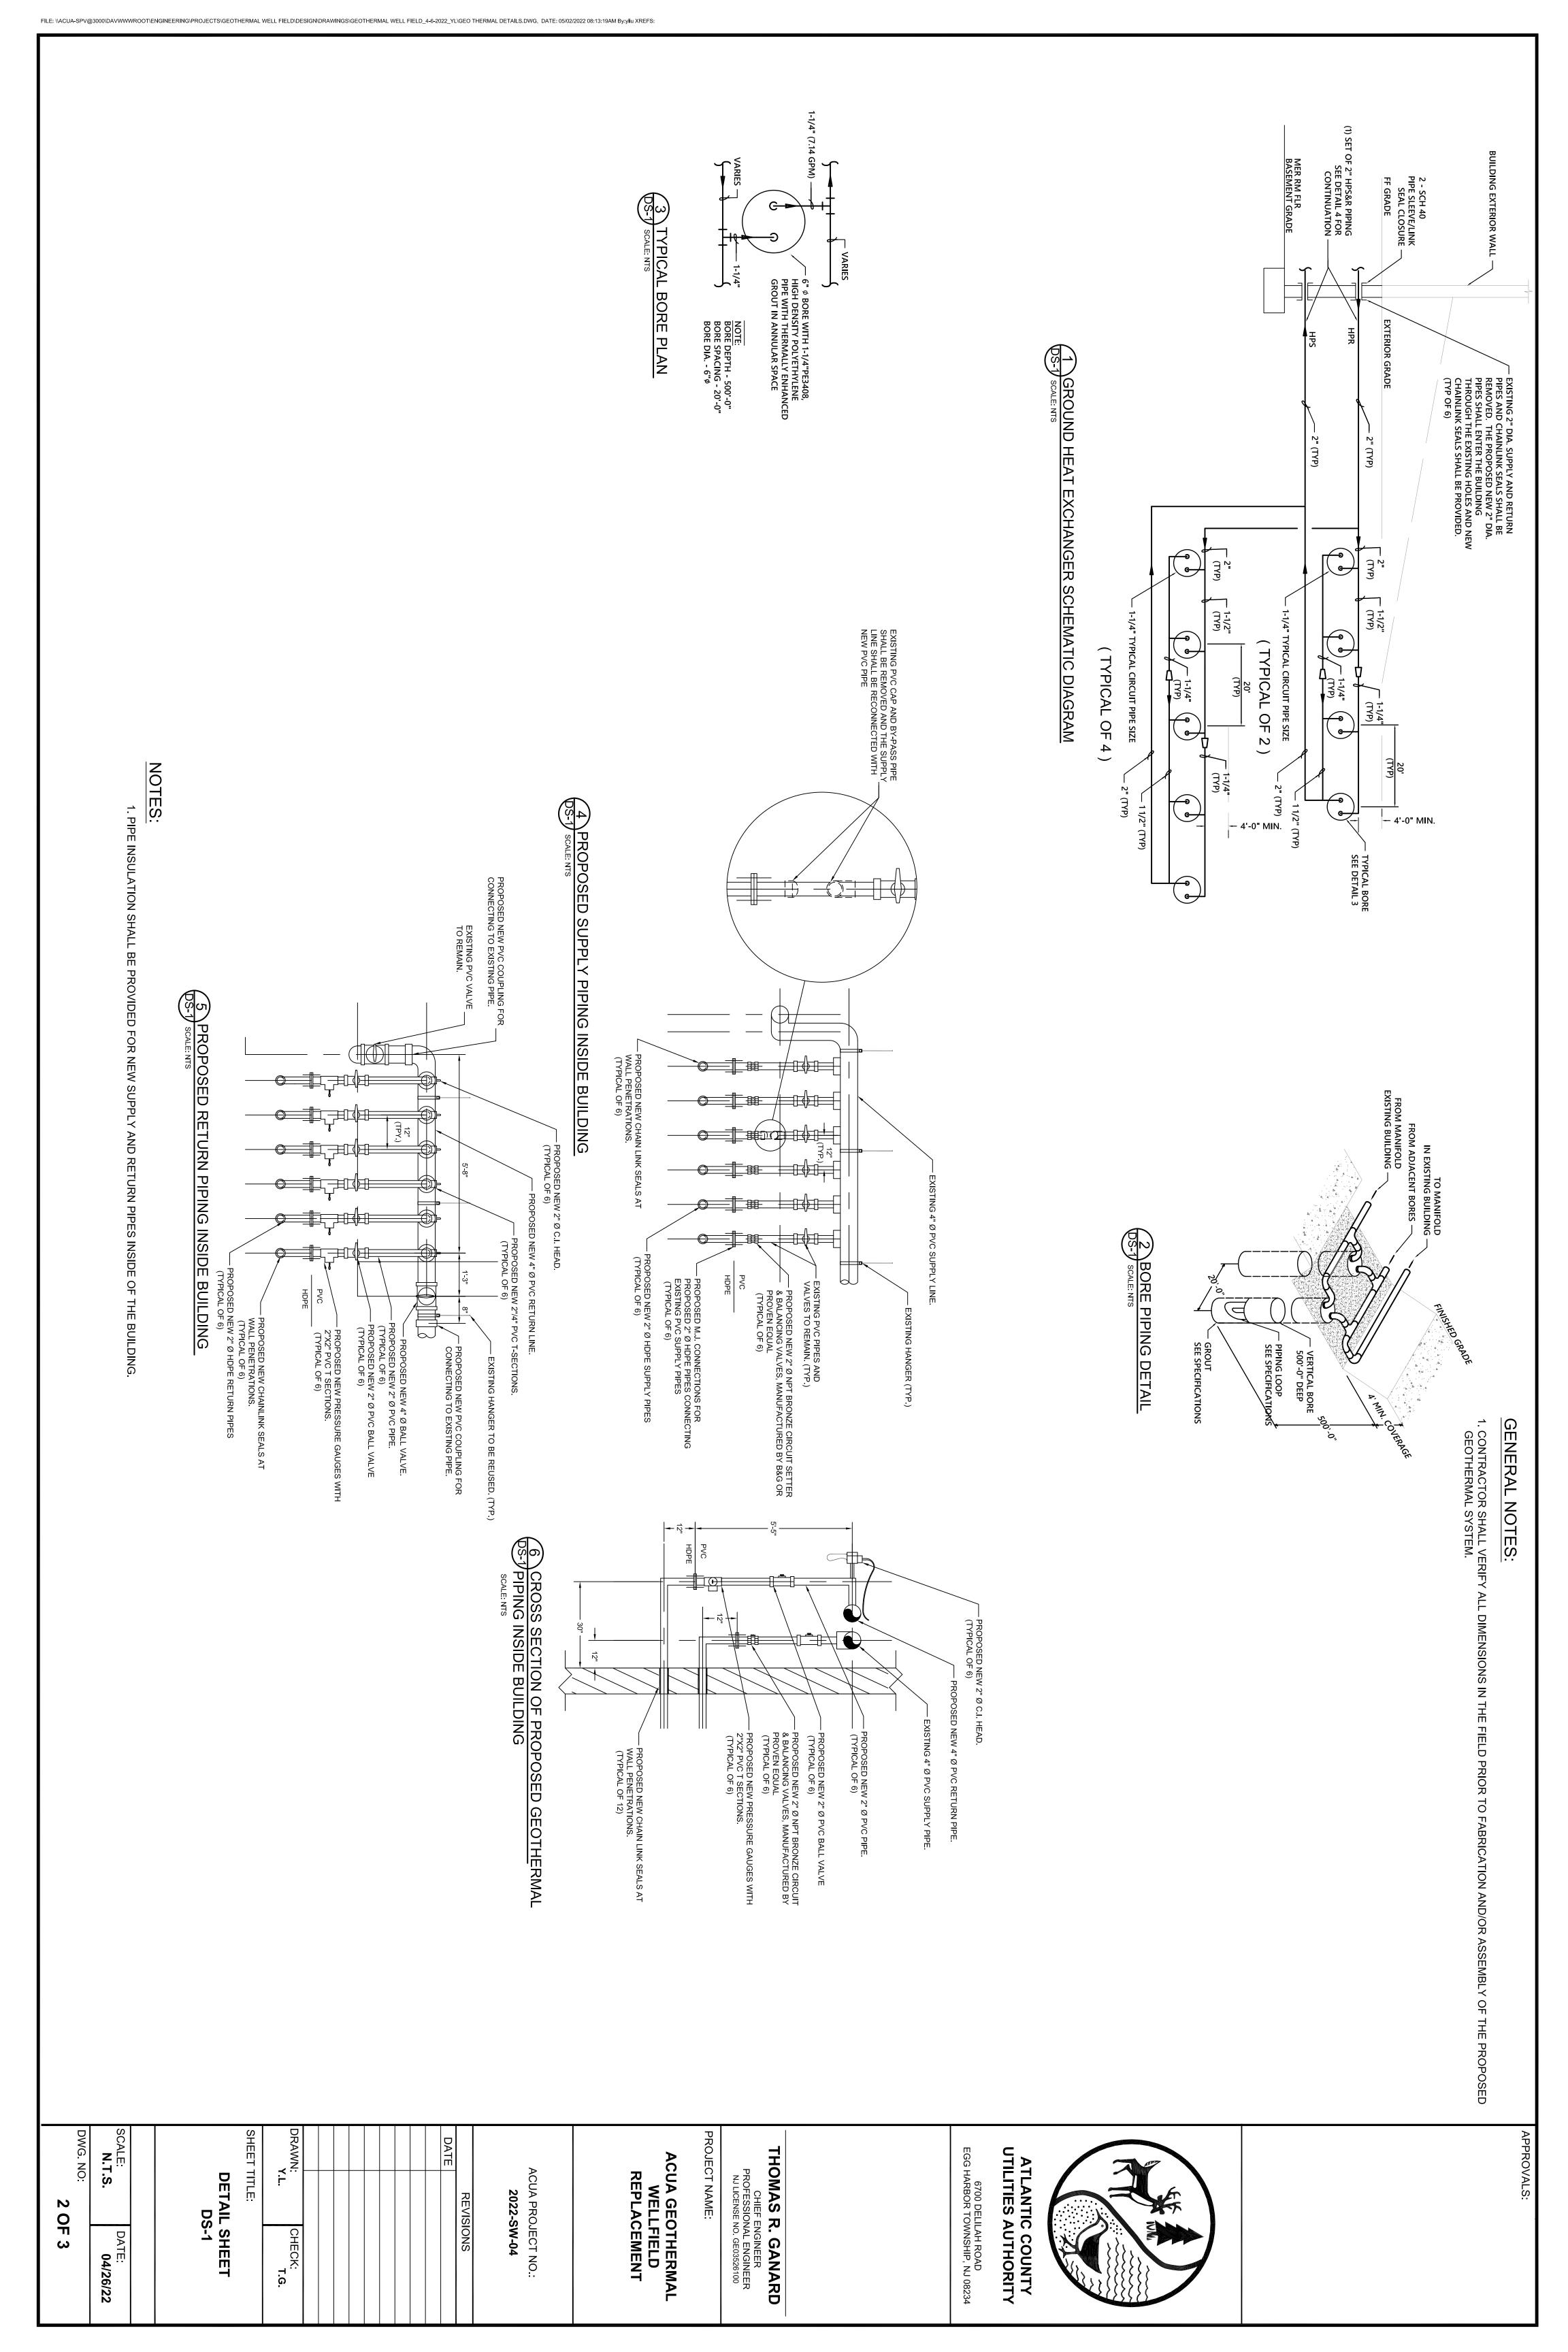

MANUFACTURE: MODEL:

ITT BELL & GOSSETT, MORTON GROVE, 2G 12.75 BF

USA

200 G.P.M 160 F.T. 15 H.P. 1800 R.P MAX. WORK PRESSURE: 175 P.S.I. 208V / 3HP / 60HZ

. ≥

EXISTING PUMPS


(2)

TO BE

REPLACED

NOTE:
1. THE EXISTING B&G 2G PUMP HAS BEEN DISCONTINUED.
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PROVIDE B&G e-1510, 2GB, 12.5 IMPELLER, 200GPM, 160'HD, 15
HP, 1750 RPM, 208V/3PH/60HZ OR PROVEN EQUAL. (PROVIDE
VFD/DISCONNECT FOR BALANCING PURPOSES ONLY)

CIFICATIONS

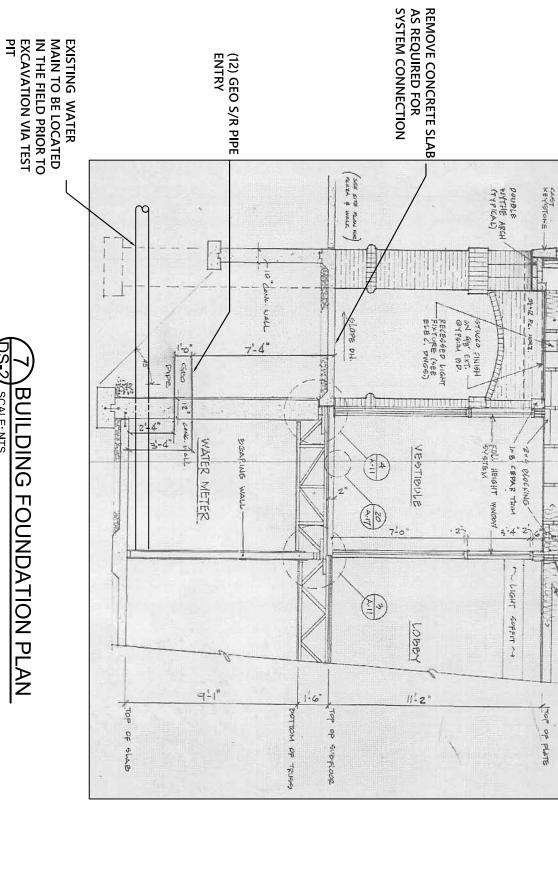

10-12

TO TOP OF SLAB

CRETE SLAB W/ 6" X 6", 10/10 W.W.M. SHALL BE RESTORED TO ITS ORIGINAL CONDITION.

NOTE:

EXISTING

4


THICK CON

% + ANCHOR BOLTS @



7 BUILDING DS-2 SCALE: NTS


FOUNDATION PLAN

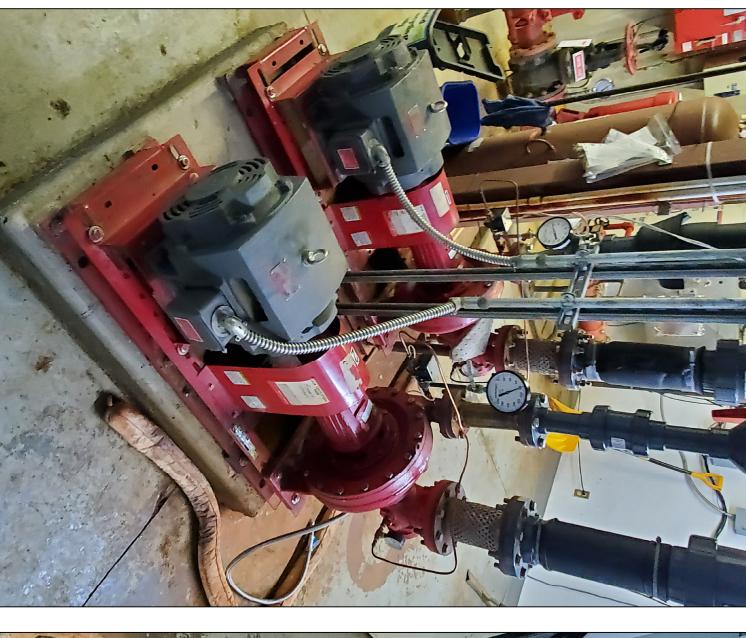





EX. PUMP TRIM TO REMAIN

PROVIDE NEW SUCTION DIFFUSER AND PUMPS CLEAN, REPAIR AND PAINT EXISTING PUMP HOUSEKEEPING PAD

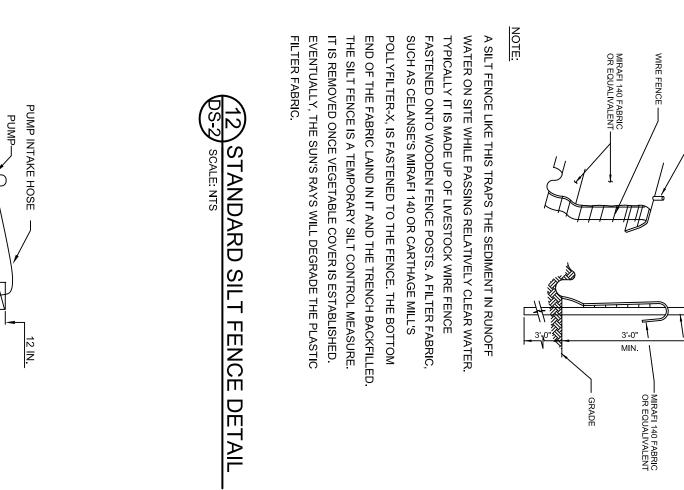

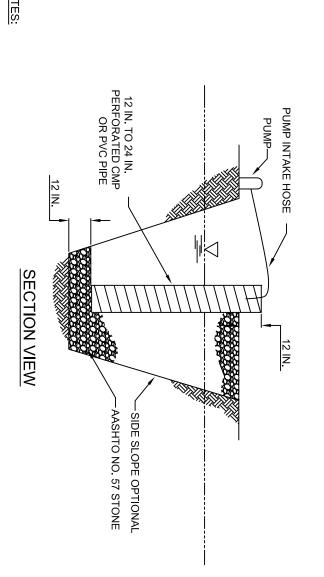


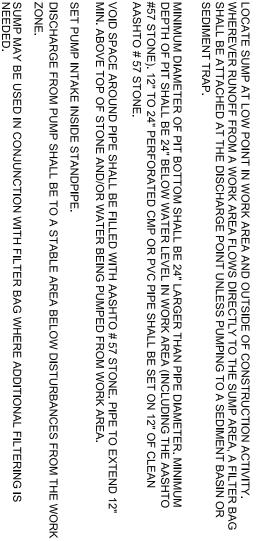





GENERAL NOTES:

1. CONTRACTOR SHALL VERIFY ALL DIMENSIONS IN THE FIELD PRIOR TO FABRICATION AND/OR ASSEMBLY OF THE PROPOSED GEOTHERMAL SYSTEM.

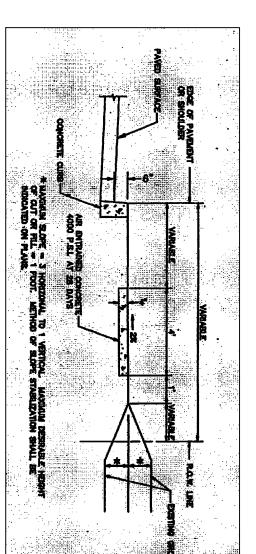


NOTE: EXISTING 4" THICK CONCRETE SIDEWALK SHALL BE RESTORED TO ITS ORIGINAL CONDITION.

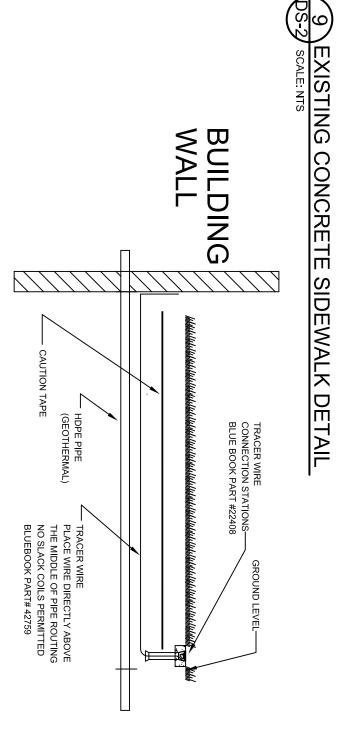

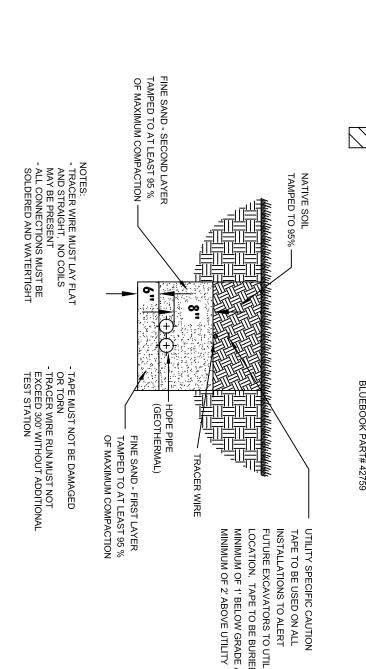



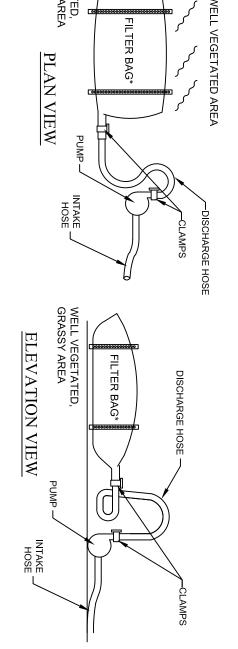

- 1. FILTER BAGS SHALL BE MADE FROM NON-WOVEN GEOTEXTILE MATERIAL SEWN WITH HIGH STRENGTH, DOUBLE STITCHED "J" TYPE SEAMS. THEY SHALL BE CAPABLE OF TRAPPING PARTICLES LARGER THAN 150 MICRONS.

 2. A SUITABLE MEANS OF ACCESSING THE BAG WITH MACHINERY REQUIRED FOR DISPOSAL PURPOSES MUST BE PROVIDED. FILTER BAGS SHALL BE REPLACED WHEN THEY BECOME ½ FULL. SPARE BAGS SHALL BE KEPT AVAILABLE FOR REPLACEMENT OF THOSE THAT HAVE FAILED OR ARE FILLED.

 3. BAGS SHALL BE LOCATED IN WELL-VEGETATED (GRASSY) AREAS, AND DISCHARGE ONTO STABLE, EROSION RESISTANT AREAS. WHERE THIS IS NOT POSSIBLE, A GEOTEXTILE FLOW PATH SHALL BE PROVIDED. BAGS SHALL NOT BE PLACED ON SLOPES GREATER THAN 5%.

DRAWN:

CHECK: T.G.

SHEET TITLE:

DETAIL SHEET DS-2

- THE PUMP DISCHARGE HOSE SHALL BE INSERTED INTO THE BAGS IN THE MANNER SPECIFIED BY THE MANUFACTURER AND SECURELY CLAMPED.
 THE PUMPING RATE SHALL BE NO GREATER THAN 750 GPM OR ½ THE MAXIMUM SPECIFIED BY THE MANUFACTURER, WHICHEVER IS LESS. PUMP INTAKES SHOULD BE FLOATING AND SCREENED.
- 6. FILTER BAGS SHALL BE INSPECTED DAILY. IF ANY PROBLEM IS DETECTED, PUMPING SHALL CEASE IMMEDIATELY AND NOT RESUME UNTIL THE PROBLEM IS CORRECTED.



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